CITY OF ALBERT LEA HERITAGE PRESERVATION COMMISSION

October 14, 2025, 7:00 p.m. City Center

AGENDA

- A. CALL TO ORDER AND ROLL CALL
- B. APPROVAL OF THE AGENDA
- C. APPROVAL OF MINUTES
 - 1. September 17, 2025
- D. PUBLIC HEARINGS
 - 1. Certificate of Appropriateness 415 Washington Ave S
- E. NEW BUSINESS
- F. COMMISSIONER COMMUNICATIONS
- G. STAFF COMMUNICATIONS
 - 1. Introduction of Risha Ericksmoen
- H. ADJOURNMENT

Disclaimer: This agenda has been prepared to provide information regarding an upcoming meeting of the Heritage Preservation Commission of the City of Albert Lea. This document does not claim to be complete and is subject to change.

MINUTES OF THE ALBERT LEA HERITAGE PRESERVATION COMMISSION

Special Meeting September 17, 2025 5:30 pm – City Center

Call to order at 1:00pm by Brad Kirchner.

MEMBERS PRESENT: Jennifer Levisen, Brad Kirchner, Tarrah Hall-Sather, and Nic Lang.

MEMBERS ABSENT: Tom Staker, Stephanie Kibler, Linda Bryan, and Larry Baker.

STAFF PRESENT: Megan Boeck, City Planner.

INTERESTED PARTIES: None.

APPROVAL OF AGENDA

A motion was made by Hall-Sather and second by Levisen to approve the agenda. Motion carried.

APPROVAL OF MINUTES

A motion was made by Hall-Sather and second by Levisen to approve the August 12, 2025 meeting minutes. Motion carried.

PUBLIC HEARINGS

None.

NEW BUSINESS

1) Certificates of Appropriateness – Staff Approvals

Boeck reviewed the COA's that were granted staff approvals in recent months.

COMMISSIONER COMMUNICATION

None.

STAFF COMMUNICATION

1) Board and Commission Update

Boeck stated that Stephanie Kibler resigned from the Freeborn County Historical Museum and as such resigned from the HPC as well. Boeck also stated that Kibler recommended another museum staffer, Risha Erickmoen, Curator of Collections and Exhibits, as commissioner replacement.

Boeck also stated that Pam Schmidt recently applied to the Heritage Preservation Commission and that her application can be considered at the end of the year when there are term expirations.

ADJOURNMENT

Motion by Levisen and second by Ho Motion carried.	all-Sather to adjourn the meeting at 1:20pm
Megan Boeck, City Planner	
 Brad Kirchner. Vice Chairman	



TO: Heritage Preservation Commission FROM: Megan N. Boeck, City Planner

DATE: October 10, 2025

RE: Certificate of Appropriateness – 415 Washington Ave S – CA2025-014

The applicant, Mark Habben, has applied for a certificate of appropriateness for 415 Washington Ave S (registered as 110 West Pearl) for exterior repairs and/or modifications consisting of:

- 1) Tuckpointing structural cracks throughout the building as needed
- 2) Repairing stucco on east side of building
- 3) Painting stucco on north and east walls once repairs are completed
- 4) Installing structural stairs with rods on 2nd floor area where veneer is separating from masonry structure to reinforce and stabilize wall
- 5) Installing new overhead door on north wall dimensions were not provided
- 6) Window replacement expected in the future no additional details were provided



North



West



South



Updated design guidelines require repointing areas only where needed which has been proposed by the applicant. Guidelines also state that repairs should match the historic condition as closely as possible.

In addition, stucco is not considered an appropriate material but the existing stucco was likely done to the building prior to any historical designation. Design Guidelines in addition to Chapter 12 of the MN Conservation Code for Existing Buildings states that repairs to any portion of a historic building or structure shall be permitted with original or like materials and original methods of construction. Stucco is not an original material. There are additional concerns pertaining to the possibility for unknown issues or deteriorating conditions underneath the stucco due to heat and moisture trapping. Any removal or repainting should be done in a way that avoids further damage to the structure. Sandblasting and chemical strippers should be avoided.

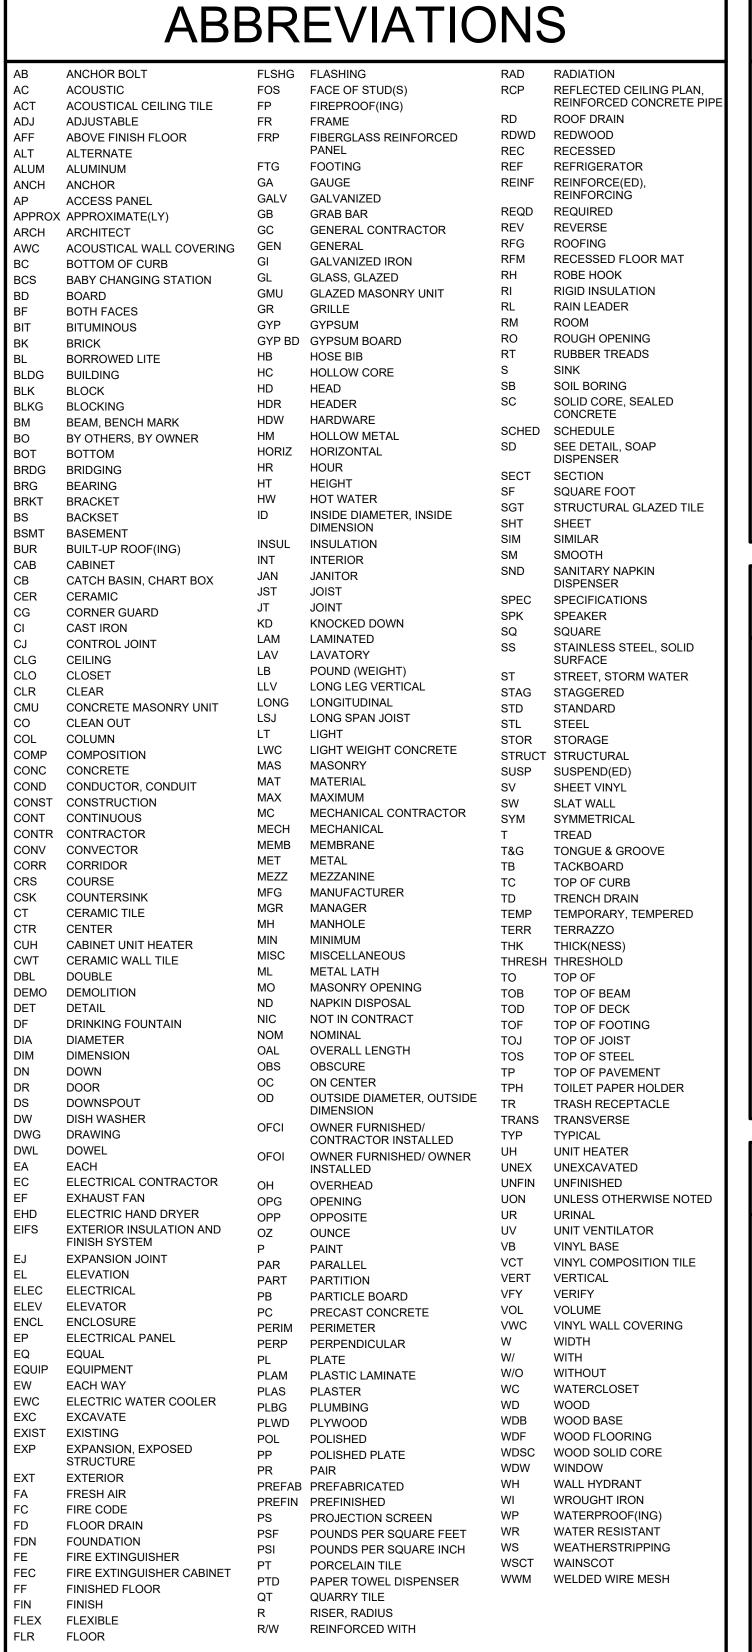
Please let me know if you have any questions.

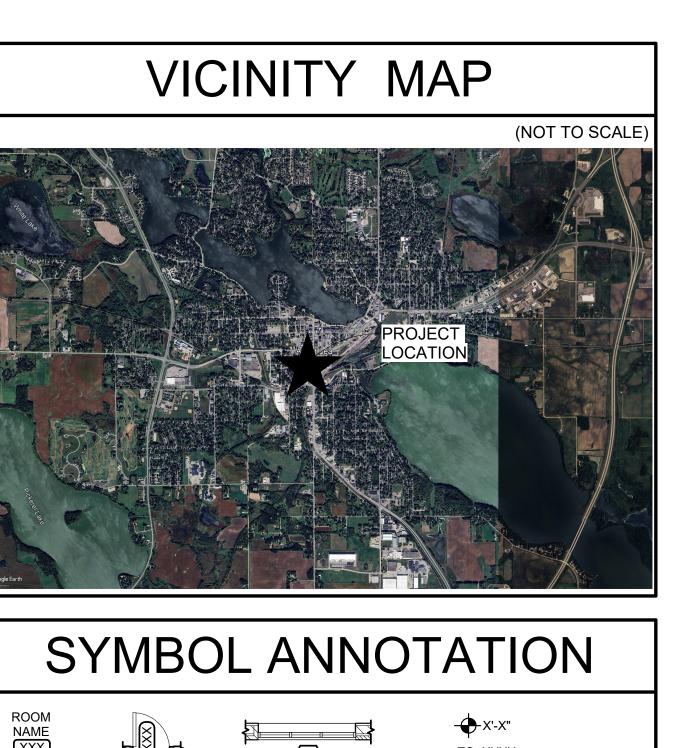
Respectfully submitted,

Megan N. Boeck, City Planner

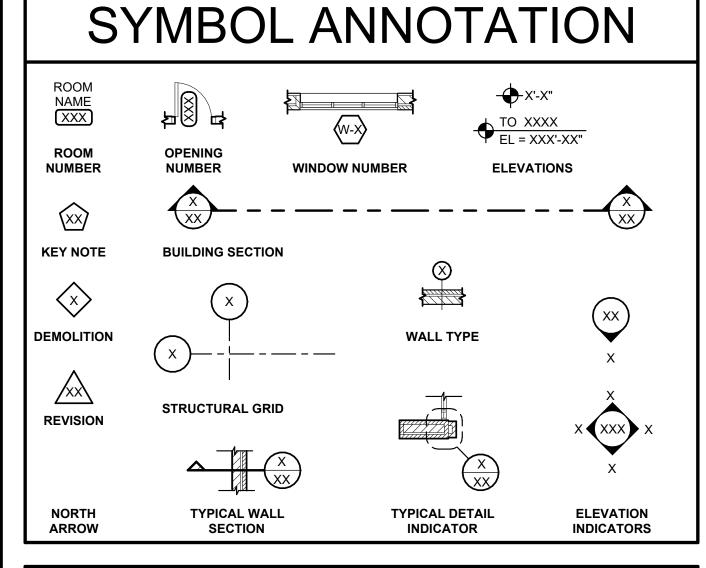
MIXED-USE TENANT REDEVELOPMENT

415 SOUTH WASHINGTON AVE









MATERIAL GRAPHICS

CLAY TILE

GYPSUM BOARD/

STONE

PLYWOOD

GRANULAR FILL

INSULATION

HD FIBERBOARD

FINISHED WOOD

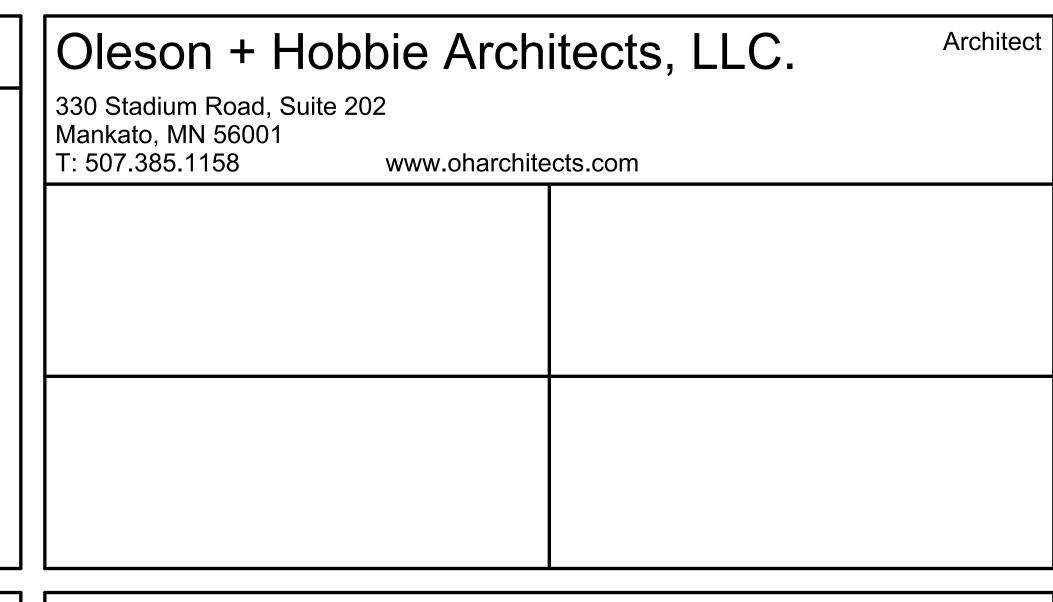
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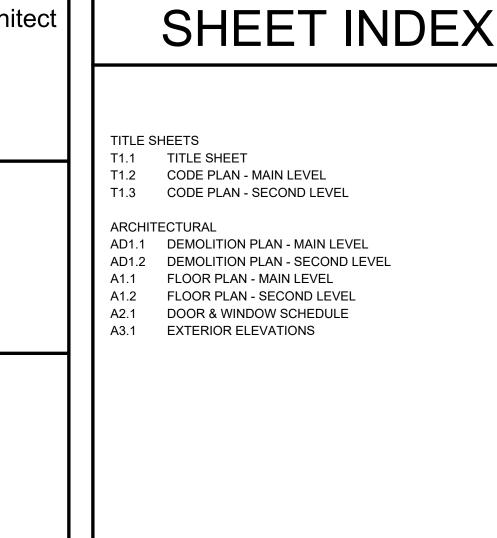
CEILING TILE

PARTICLE

BOARD

RIGID INSULATION







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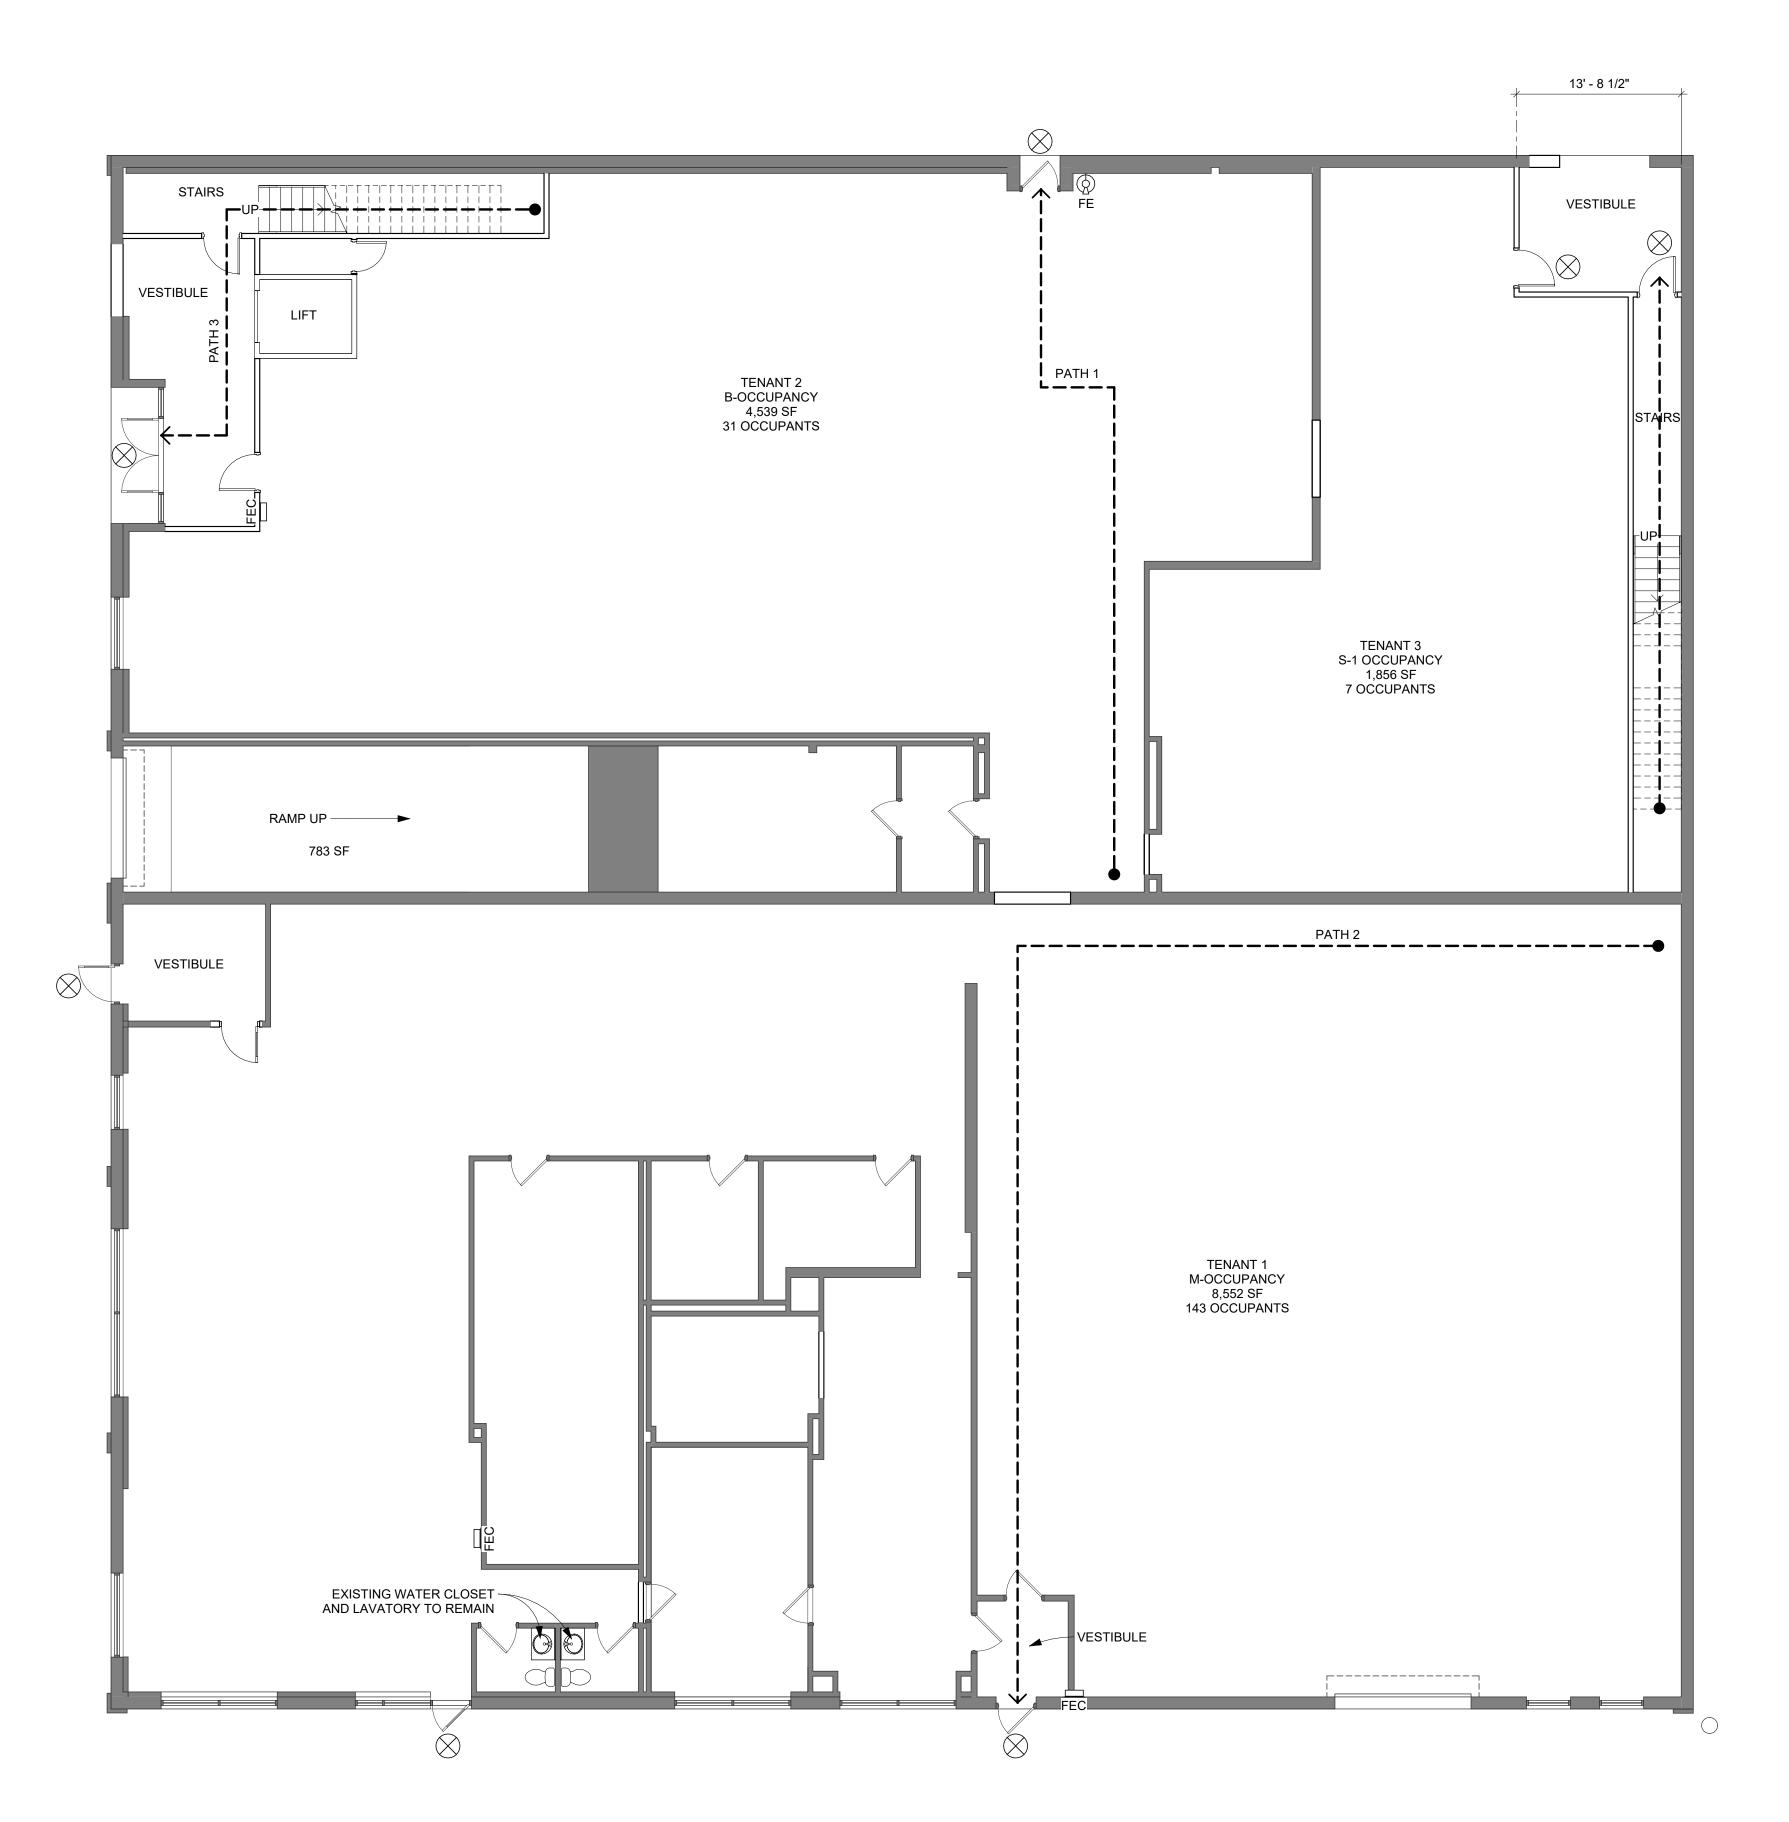
PRELIMINAR

PROJECT# 10/06/2025 DRAWN BY CHECKED BY TAA,DGH © 2025 OLESON+HOBBIE ARCHITECTS, LLC

TITLE SHEET

SHEET TITLE

SET NO.



CODE PLAN - MAIN LEVEL T1.2 / SCALE: 1/8" = 1'-0"

TRAVEL DISTANCE PATH 1 63' - 2" PATH 2 | 116' - 4" PATH 3 210' - 2" PATH 4 | 206' - 7"

a fire-resistance rating.

CODE LEGEND —1HR——1HR—— 1 HOUR FIRE RATED PARTITION EXIT FIRE EXTINGUISHER FIRE EXTINGUISHER CABINET

CODE REVIEW 415 South Washington Building Renovations TENANT 2 – Group B Occupancy The project includes selective demolition and construction Per Table 1006.2.1, the First Floor Group B occupancy 31 Occupants (16 Men / 16 Women) of interior renovations to the first and second floors of the requires one exit since the occupant load is less than 49. existing building located at 415 South Washington in Albert Lea. The intent is to convert underutilized areas of <u>Water closets</u> Per Table 1006.2.1, the First Floor Group M occupancy Men: 1 per 25 for the first 50 and 1 per 50 for the the building into new tenant spaces in a mixed use development. Work will include selective demolition, requires two exits since the occupant load is greater than 29 remainder (16 Occupants) 1 Water closet required interior partitions, floor and wall finishes, acoustical but less than 500. ceilings, doors, frames and hardware, windows and 1 Water closet provided Women: 1 per 25 for the first 50 and 1 per 50 for the borrowed lights, wheelchair lift, plumbing equipment and Per Table 1006.2.1, the First Floor Group S-1 occupancy remainder (16 Occupants) fixtures, mechanical equipment, electrical power systems, requires one exit since the occupant load is less than 29. 1 Water closet required and lighting for tenant improvements. Per Table 1006.2.1, the Second Floor Group B occupancy 1 Water closet provided requires two exits since the occupant load is greater than 49 Design Codes 2020 Minnesota Building Code but less than 500. 2024 Minnesota Energy Code Men: 1 per 40 for the first 80 and 1 per 80 for the 2020 Minnesota Accessibility Code COMMON PATH OF EGRESS TRAVEL remainder (16 Occupants) 2020 Minnesota Mechanical and Fuel Gas Code 1 Lavatory required 2020 Minnesota Plumbing Code Per Table 1006.2.1, the maximum length of the common 1 Lavatory provided Women: 1 per 40 for the first 80 and 1 per 80 for the 2020 Minnesota Fire Code path of egress travel is 100 feet for the First Floor Group B 2020 Minnesota Electrical Code remainder (16 Occupants) occupancy since the building is fully fire sprinkled. 1 Lavatory required 2020 Minnesota Conservation Code Per Table 1006.2.1, the maximum length of the common 1 Lavatory provided **BUILDING AREA** path of egress travel is 75 feet for the First Floor Group M occupancy since the building is fully fire sprinkled. **Drinking Fountains** Group B, M, S-1 Occupancies The M Occupancy requires 1 drinking fountain for every Per Table 1006.2.1, the maximum length of the common Type V-B Construction / Masonry & Wood path of egress travel is 100 feet for the First Floor Group S-1 100 occupants Fully Sprinklered occupancy since the building is fully fire sprinkled. 1 drinking fountain required 1 drinking fountain provided Allowable Area from Table 506.2 Occupancy Group B = 27,000 SF Sprinklered multi-story Per Table 1006.2.1, the maximum length of the common Occupancy Group M = 27,000 SF Sprinklered multi-story path of egress travel is 100 feet for the Second Floor Group TENANT 3 – Group S-1 Occupancy Occupancy Group S-1 = 27,000 SF Sprinklered multi- B occupancy since the building is fully fire sprinkled. In accordance with the exception included in MSBC EXIT ACCESS TRAVEL DISTANCE 2902.1, restrooms facilities are not required in buildings Actual Area First Floor = 16,414 SF (8,552 SF M / 1,856 SF S-1 / Per Table 1017.2, the maximum length for B exit access normally unoccupied. travel is 300 feet in a fully sprinklered building. 4,539 SF B) Second Floor = 16,544 SF B Occupancy Per Table 1017.2, the maximum length for M & S-1 exit When approved by the building official, buildings or Total Area = 32,958 SF access travel is 250 feet in a fully sprinklered building. structures that are normally unoccupied, such as picnic shelters, amphitheaters, small transit stop stations, cold-Allowable Height from Table 504.3 storage buildings, utility sheds, warming houses, kiosks, OCCUPANT LOADS concession stands and similar structures, need not be 60 Feet (Type V, Fully-sprinklered) provided with restroom facilities. First Floor Commercial Space - Occupancy Group B = 4,539 SF Actual Height SECOND FLOOR: Approximately 24'-0" Occupancy load factor = 150 gross First Floor Retail Space - Occupancy Group M TENANT 1 – Group B Occupancy Allowable Number of Stories from Table 504.4 8,552 SF Occupancy Group B = 3 Stories (Type V, Fully-Occupancy load factor = 60 gross First Floor Retail Space - Occupancy Group S-1 111 Occupants (56 Men / 56 Women) Sprinklered) Occupancy Group M = 2 Stories (Type V, Fully-Separate facilities shall not be required in structures or Sprinklered) Occupancy load factor = 300 gross Occupancy Group S-1 = 2 Stories (Type V, Fullytenant spaces with a total occupant load, including both First Commercial Space - Occupancy Group B employees and customers, of 25 or less. Occupancy load factor = 150 gross Water closets
Men: 1 per 25 for the first 50 then 1 per 50 for the Actual Number of Stories First level floor occupancy Group B = 4,539/150 Gross = 2 Stories remainder exceeding 50 (56 Occupants). 30.26 Occupants or 31 occupants **SEPARATION OF OCCUPANCIES** 2 Water closets required First level floor occupancy Group M = 8,552/60 Gross = 2 Water closets provided 142.53 Occupants or 143 occupants Women: 1 per 25 for the first 50 then 1 per 50 for the Separation between occupancies will be in accordance First level floor occupancy Group S-1 = 1,856/300 Gross = remainder exceeding 50 (56 Occupants). with Required separation in Table 508.4 6.19 Occupants or 7 occupants 2 Water closets required Total First Floor Occupants = 181 occupants 2 Water closets provided 1. Separation between occupancy B and M = No Second level floor occupancy Group B = 16,544/150 separation is required for fully-sprinkled facilities. 2. Separation between occupancy B and S-1 = No Gross = 110.29 Occupants or 111 occupants Men: 1 per 40 for the first 80 then 1 per 80 for the separation is required for fully-sprinkled facilities. Total Second Floor Occupants = 111 occupants remainder exceeding 80 (56 Occupants 3. Separation between occupancy M and S-1 = No Total Building Occupants = 292 occupants separation is required for fully-sprinkled facilities 1 Lavatory required PLUMBING FACILITIES 1 Lavatory provided Women: 1 per 40 for the first 80 then 1 per 80 for the FIRE PROTECTION remainder exceeding 80 (56 Occupants FIRST FLOOR: 1 Lavatory required No automatic sprinkler system is required in stories and 1 Lavatory provided areas containing a Group B occupancy. TENANT 1 – Group M Occupancy **Drinking Fountains** 143 Occupants (72 Men / 72 Women) An automatic sprinkler system shall be provided throughout buildings containing a Group M occupancy A Drinking Fountain is required in B Occupancies for where one of the following conditions exists: every 100 occupants Men: 1 per 500 required (72 Occupants) 2 drinking fountains required 1.A Group M fire area exceeds 12,000 square feet. 1 Water closet required 2 Drinking Fountains provided 2.A Group M fire area is located more than three stories 1 Water closet provided Women: 1 per 500 required (72 Occupants) above grade plane. 3. The combined area of all Group M fire areas on all 1 Water closet required floors, including any mezzanines, exceeds 24,000 square 1 Water closet provided 4.A Group M occupancy used for the display and sale of <u>Lavatories</u> upholstered furniture or mattresses exceeds 5,000 square Men: 1 per 750 required (72 Occupants) 1 Lavatory required 1 Lavatory provided None of these conditions exist, therefore, an automatic fire Women: 1 per 750 required (72 Occupants) sprinkling system is not required for the Group M 1 Lavatory required An automatic sprinkler system shall be provided **Drinking Fountains** throughout all buildings containing a group S-1 occupancy The M Occupancy requires 1 drinking fountain for every where one of the following conditions exists: 1.A Group S-1 fire area exceeds 12,000 square feet. 1 drinking fountain required 2.A Group S-1 fire area is located more than three stories 1 drinking fountain provided above grade plane. 3. The combined area of all Group S-1 fire areas on all floors, including any mezzanines, exceeds 24,000 square 4.A Group S-1 fire area used for the storage of commercial motor vehicles where the fire area exceeds 5,000 square feet. None of these conditions exist, therefore, an automatic fire sprinkling system is not required for the Group S-1 The existing sprinkling system will be refurbished and operational through the entire building. FIRE RESISTANCE RATINGS Per Table 601, there are no building elements that require

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PROJECT# 25-046AL 10/06/2025


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SHEET TITLE

CODE PLAN -

MAIN LEVEL



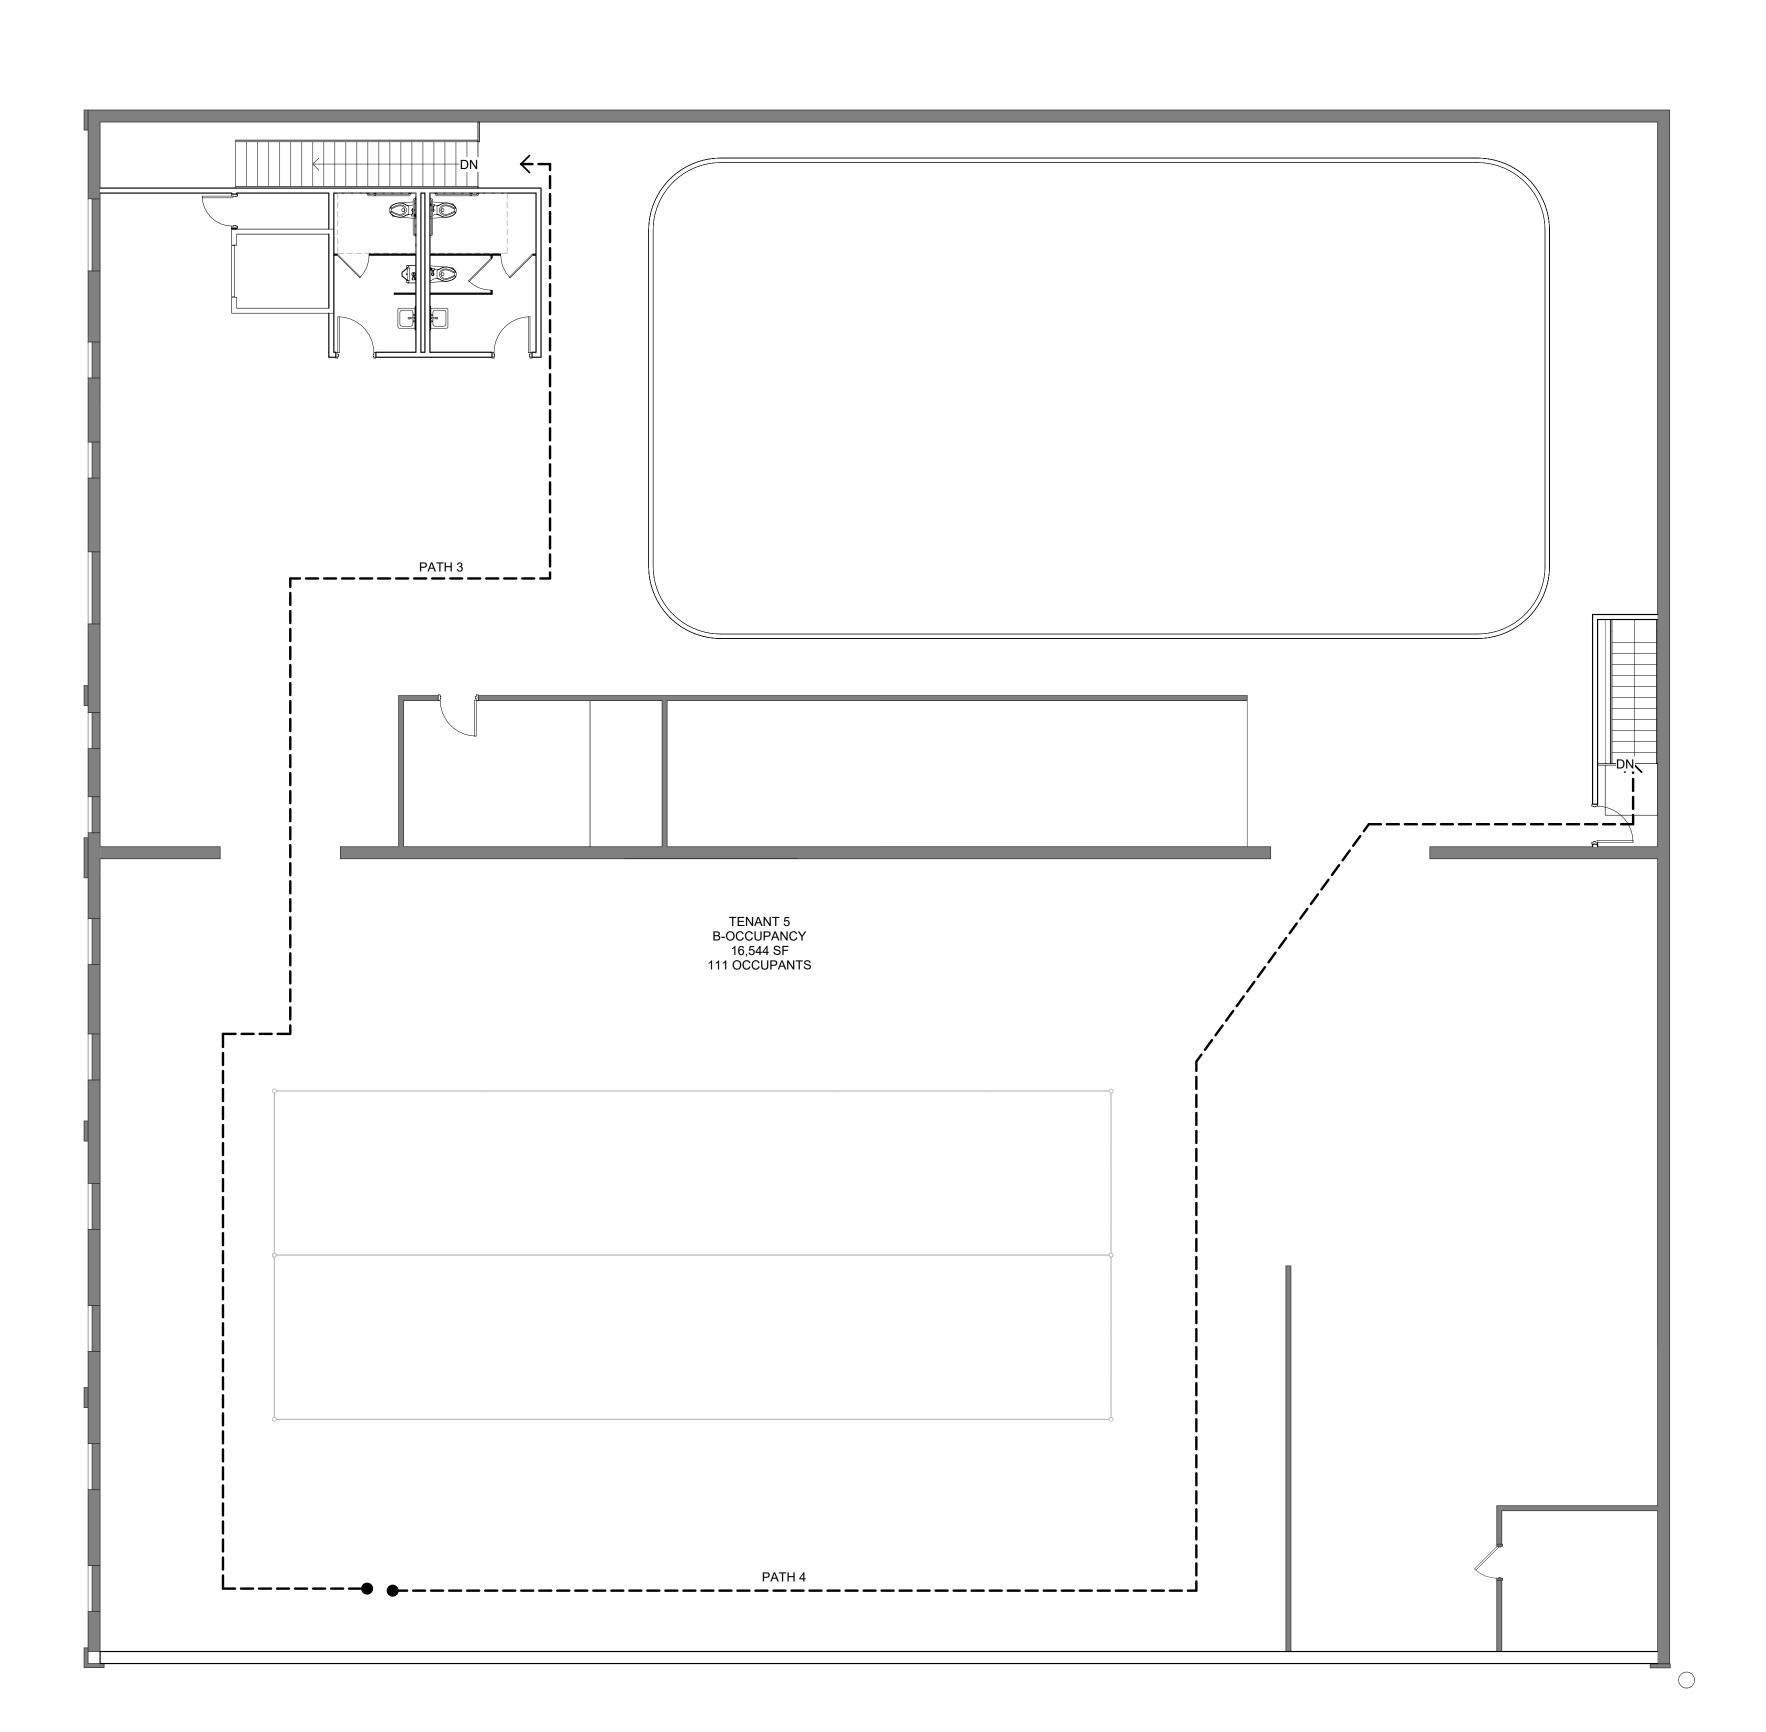CODE PLAN - SECOND LEVEL T1.3 / SCALE: 1/8" = 1'-0"

PATH 1 63' - 2" PATH 2 116' - 4" PATH 3 210' - 2"

TRAVEL DISTANCE PATH 4 206' - 7"

CODE LEGEND

—1HR—— 1 HOUR FIRE RATED PARTITION

EXIT

FIRE EXTINGUISHER

FIRE EXTINGUISHER CABINET

CODE REVIEW

415 South Washington Building Renovations

The project includes selective demolition and construction of interior renovations to the first and second floors of the Per Table 1006.2.1, the First Floor Group B occupancy existing building located at 415 South Washington in Albert Lea. The intent is to convert underutilized areas of the building into new tenant spaces in a mixed use development. Work will include selective demolition,

interior partitions, floor and wall finishes, acoustical ceilings, doors, frames and hardware, windows and borrowed lights, wheelchair lift, plumbing equipment and Per Table 1006.2.1, the First Floor Group S-1 occupancy fixtures, mechanical equipment, electrical power systems, requires one exit since the occupant load is less than 29. and lighting for tenant improvements.

Design Codes 2020 Minnesota Building Code 2024 Minnesota Energy Code 2020 Minnesota Accessibility Code 2020 Minnesota Mechanical and Fuel Gas Code 2020 Minnesota Plumbing Code 2020 Minnesota Fire Code

BUILDING AREA

Group B, M, S-1 Occupancies Type V-B Construction / Masonry & Wood Fully Sprinklered

2020 Minnesota Electrical Code

2020 Minnesota Conservation Code

Allowable Area from Table 506.2 Occupancy Group B = 27,000 SF Sprinklered multi-story Per Table 1006.2.1, the maximum length of the common Occupancy Group S-1 = 27,000 SF Sprinklered multi- B occupancy since the building is fully fire sprinkled.

First Floor = 16,414 SF (8,552 SF M / 1,856 SF S-1 / 4,539 SF B) Second Floor = 16,544 SF B Occupancy Total Area = 32,958 SF

Allowable Height from Table 504.3 60 Feet (Type V, Fully-sprinklered)

Actual Height

Approximately 24'-0"

Allowable Number of Stories from Table 504.4 Occupancy Group B = 3 Stories (Type V, Fully-Sprinklered) Occupancy Group M = 2 Stories (Type V, Fully-

Sprinklered) Occupancy Group S-1 = 2 Stories (Type V, Fully-Sprinklered)

Actual Number of Stories

SEPARATION OF OCCUPANCIES

Separation between occupancies will be in accordance with Required separation in Table 508.4

1. Separation between occupancy B and M = No separation is required for fully-sprinkled facilities. 2. Separation between occupancy B and S-1 = No separation is required for fully-sprinkled facilities. 3. Separation between occupancy M and S-1 = No separation is required for fully-sprinkled facilities

FIRE PROTECTION

No automatic sprinkler system is required in stories and areas containing a Group B occupancy.

An automatic sprinkler system shall be provided throughout buildings containing a Group M occupancy where one of the following conditions exists:

1.A Group M fire area exceeds 12,000 square feet. 2.A Group M fire area is located more than three stories above grade plane. 3. The combined area of all Group M fire areas on all floors, including any mezzanines, exceeds 24,000 square 1 Water closet provided

4.A Group M occupancy used for the display and sale of <u>Lavatories</u> upholstered furniture or mattresses exceeds 5,000 square Men: 1 per 750 required (72 Occupants)

sprinkling system is not required for the Group M Occupancy. An automatic sprinkler system shall be provided

where one of the following conditions exists:

1.A Group S-1 fire area exceeds 12,000 square feet. 2.A Group S-1 fire area is located more than three stories 1 drinking fountain provided above grade plane.

3. The combined area of all Group S-1 fire areas on all floors, including any mezzanines, exceeds 24,000 square 4.A Group S-1 fire area used for the storage of commercial motor vehicles where the fire area exceeds 5,000 square feet.

None of these conditions exist, therefore, an automatic fire sprinkling system is not required for the Group S-1 Occupancy.

The existing sprinkling system will be refurbished and operational through the entire building.

FIRE RESISTANCE RATINGS

Per Table 601, there are no building elements that require a fire-resistance rating.

requires one exit since the occupant load is less than 49.

Per Table 1006.2.1, the First Floor Group M occupancy requires two exits since the occupant load is greater than 29 remainder (16 Occupants)

Per Table 1006.2.1, the Second Floor Group B occupancy requires two exits since the occupant load is greater than 49

but less than 500.

COMMON PATH OF EGRESS TRAVEL Per Table 1006.2.1, the maximum length of the common

path of egress travel is 100 feet for the First Floor Group B occupancy since the building is fully fire sprinkled. Per Table 1006.2.1, the maximum length of the common

path of egress travel is 75 feet for the First Floor Group M occupancy since the building is fully fire sprinkled. Per Table 1006.2.1, the maximum length of the common

Occupancy Group M = 27,000 SF Sprinklered multi-story path of egress travel is 100 feet for the Second Floor Group TENANT 3 - Group S-1 Occupancy

EXIT ACCESS TRAVEL DISTANCE

Per Table 1017.2, the maximum length for B exit access travel is 300 feet in a fully sprinklered building. Per Table 1017.2, the maximum length for M & S-1 exit access travel is 250 feet in a fully sprinklered building.

occupancy since the building is fully fire sprinkled.

OCCUPANT LOADS

First Floor Commercial Space - Occupancy Group B = 4,539 SF Occupancy load factor = 150 gross First Floor Retail Space - Occupancy Group M

8,552 SF Occupancy load factor = 60 gross First Floor Retail Space - Occupancy Group S-1 = 1,856 SF

Occupancy load factor = 300 gross First Commercial Space - Occupancy Group B 16,544 SF Occupancy load factor = 150 gross

First level floor occupancy Group B = 4,539/150 Gross = 30.26 Occupants or 31 occupants First level floor occupancy Group M = 8,552/60 Gross = 142.53 Occupants or 143 occupants First level floor occupancy Group S-1 = 1,856/300 Gross = 6.19 Occupants or 7 occupants

Total First Floor Occupants = 181 occupants

Second level floor occupancy Group B = 16,544/150 Gross = 110.29 Occupants or 111 occupants Total Second Floor Occupants = 111 occupants Total Building Occupants = 292 occupants

PLUMBING FACILITIES

FIRST FLOOR:

TENANT 1 – Group M Occupancy

143 Occupants (72 Men / 72 Women) Men: 1 per 500 required (72 Occupants)

1 Water closet required 1 Water closet provided Women: 1 per 500 required (72 Occupants) 1 Water closet required

1 Lavatory required 1 Lavatory provided None of these conditions exist, therefore, an automatic fire Women: 1 per 750 required (72 Occupants) 1 Lavatory required

Drinking Fountains

1 Lavatory provided

throughout all buildings containing a group S-1 occupancy The M Occupancy requires 1 drinking fountain for every 1000 occupants 1 drinking fountain required

TENANT 2 - Group B Occupancy

31 Occupants (16 Men / 16 Women) Water closets Men: 1 per 25 for the first 50 and 1 per 50 for the

1 Water closet required 1 Water closet provided Women: 1 per 25 for the first 50 and 1 per 50 for the remainder (16 Occupants) 1 Water closet required 1 Water closet provided

Men: 1 per 40 for the first 80 and 1 per 80 for the remainder (16 Occupants) 1 Lavatory required 1 Lavatory provided Women: 1 per 40 for the first 80 and 1 per 80 for the

1 Lavatory provided Drinking Fountains

1 Lavatory required

remainder (16 Occupants)

1 drinking fountain required

normally unoccupied.

1 drinking fountain provided

The M Occupancy requires 1 drinking fountain for every path of egress travel is 100 feet for the First Floor Group S-1 100 occupants

7 Occupants In accordance with the exception included in MSBC 2902.1, restrooms facilities are not required in buildings

When approved by the building official, buildings or structures that are normally unoccupied, such as picnic shelters, amphitheaters, small transit stop stations, coldstorage buildings, utility sheds, warming houses, kiosks, concession stands and similar structures, need not be provided with restroom facilities.

SECOND FLOOR:

TENANT 1 – Group B Occupancy

111 Occupants (56 Men / 56 Women)

Separate facilities shall not be required in structures or tenant spaces with a total occupant load, including both employees and customers, of 25 or less.

Water closets Men: 1 per 25 for the first 50 then 1 per 50 for the remainder exceeding 50 (56 Occupants). 2 Water closets required 2 Water closets provided Women: 1 per 25 for the first 50 then 1 per 50 for the

remainder exceeding 50 (56 Occupants). 2 Water closets required 2 Water closets provided

Men: 1 per 40 for the first 80 then 1 per 80 for the

remainder exceeding 80 (56 Occupants 1 Lavatory required 1 Lavatory provided Women: 1 per 40 for the first 80 then 1 per 80 for the remainder exceeding 80 (56 Occupants 1 Lavatory required

<u>Drinking Fountains</u>

1 Lavatory provided

A Drinking Fountain is required in B Occupancies for every 100 occupants 2 drinking fountains required 2 Drinking Fountains provided

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MIXED-USE TENANT

REDEVELOPMENT

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SHEET TITLE

CODE PLAN -SECOND LEVEL





NO.

D1 REMOVE EXISTING WALL TO EXTENTS INDICATED ON THE DRAWINGS.

D2 REMOVE DOOR AND FRAME.

D3 REMOVE 4" CONCRETE FLOOR IN THIS ROOM.

D4 REMOVE EXISTING GARAGE DOOR AND ASSOCIATED COMPONENT

D4 REMOVE EXISTING GARAGE DOOR AND ASSOCIATED COMPONENTS.
D5 REMOVE EXISTING STAIRS AND ASSOCIATED COMPONENTS.
D8 REMOVE WINDOW, FRAMES AND ALL ASSOCIATED COMPONENTS.

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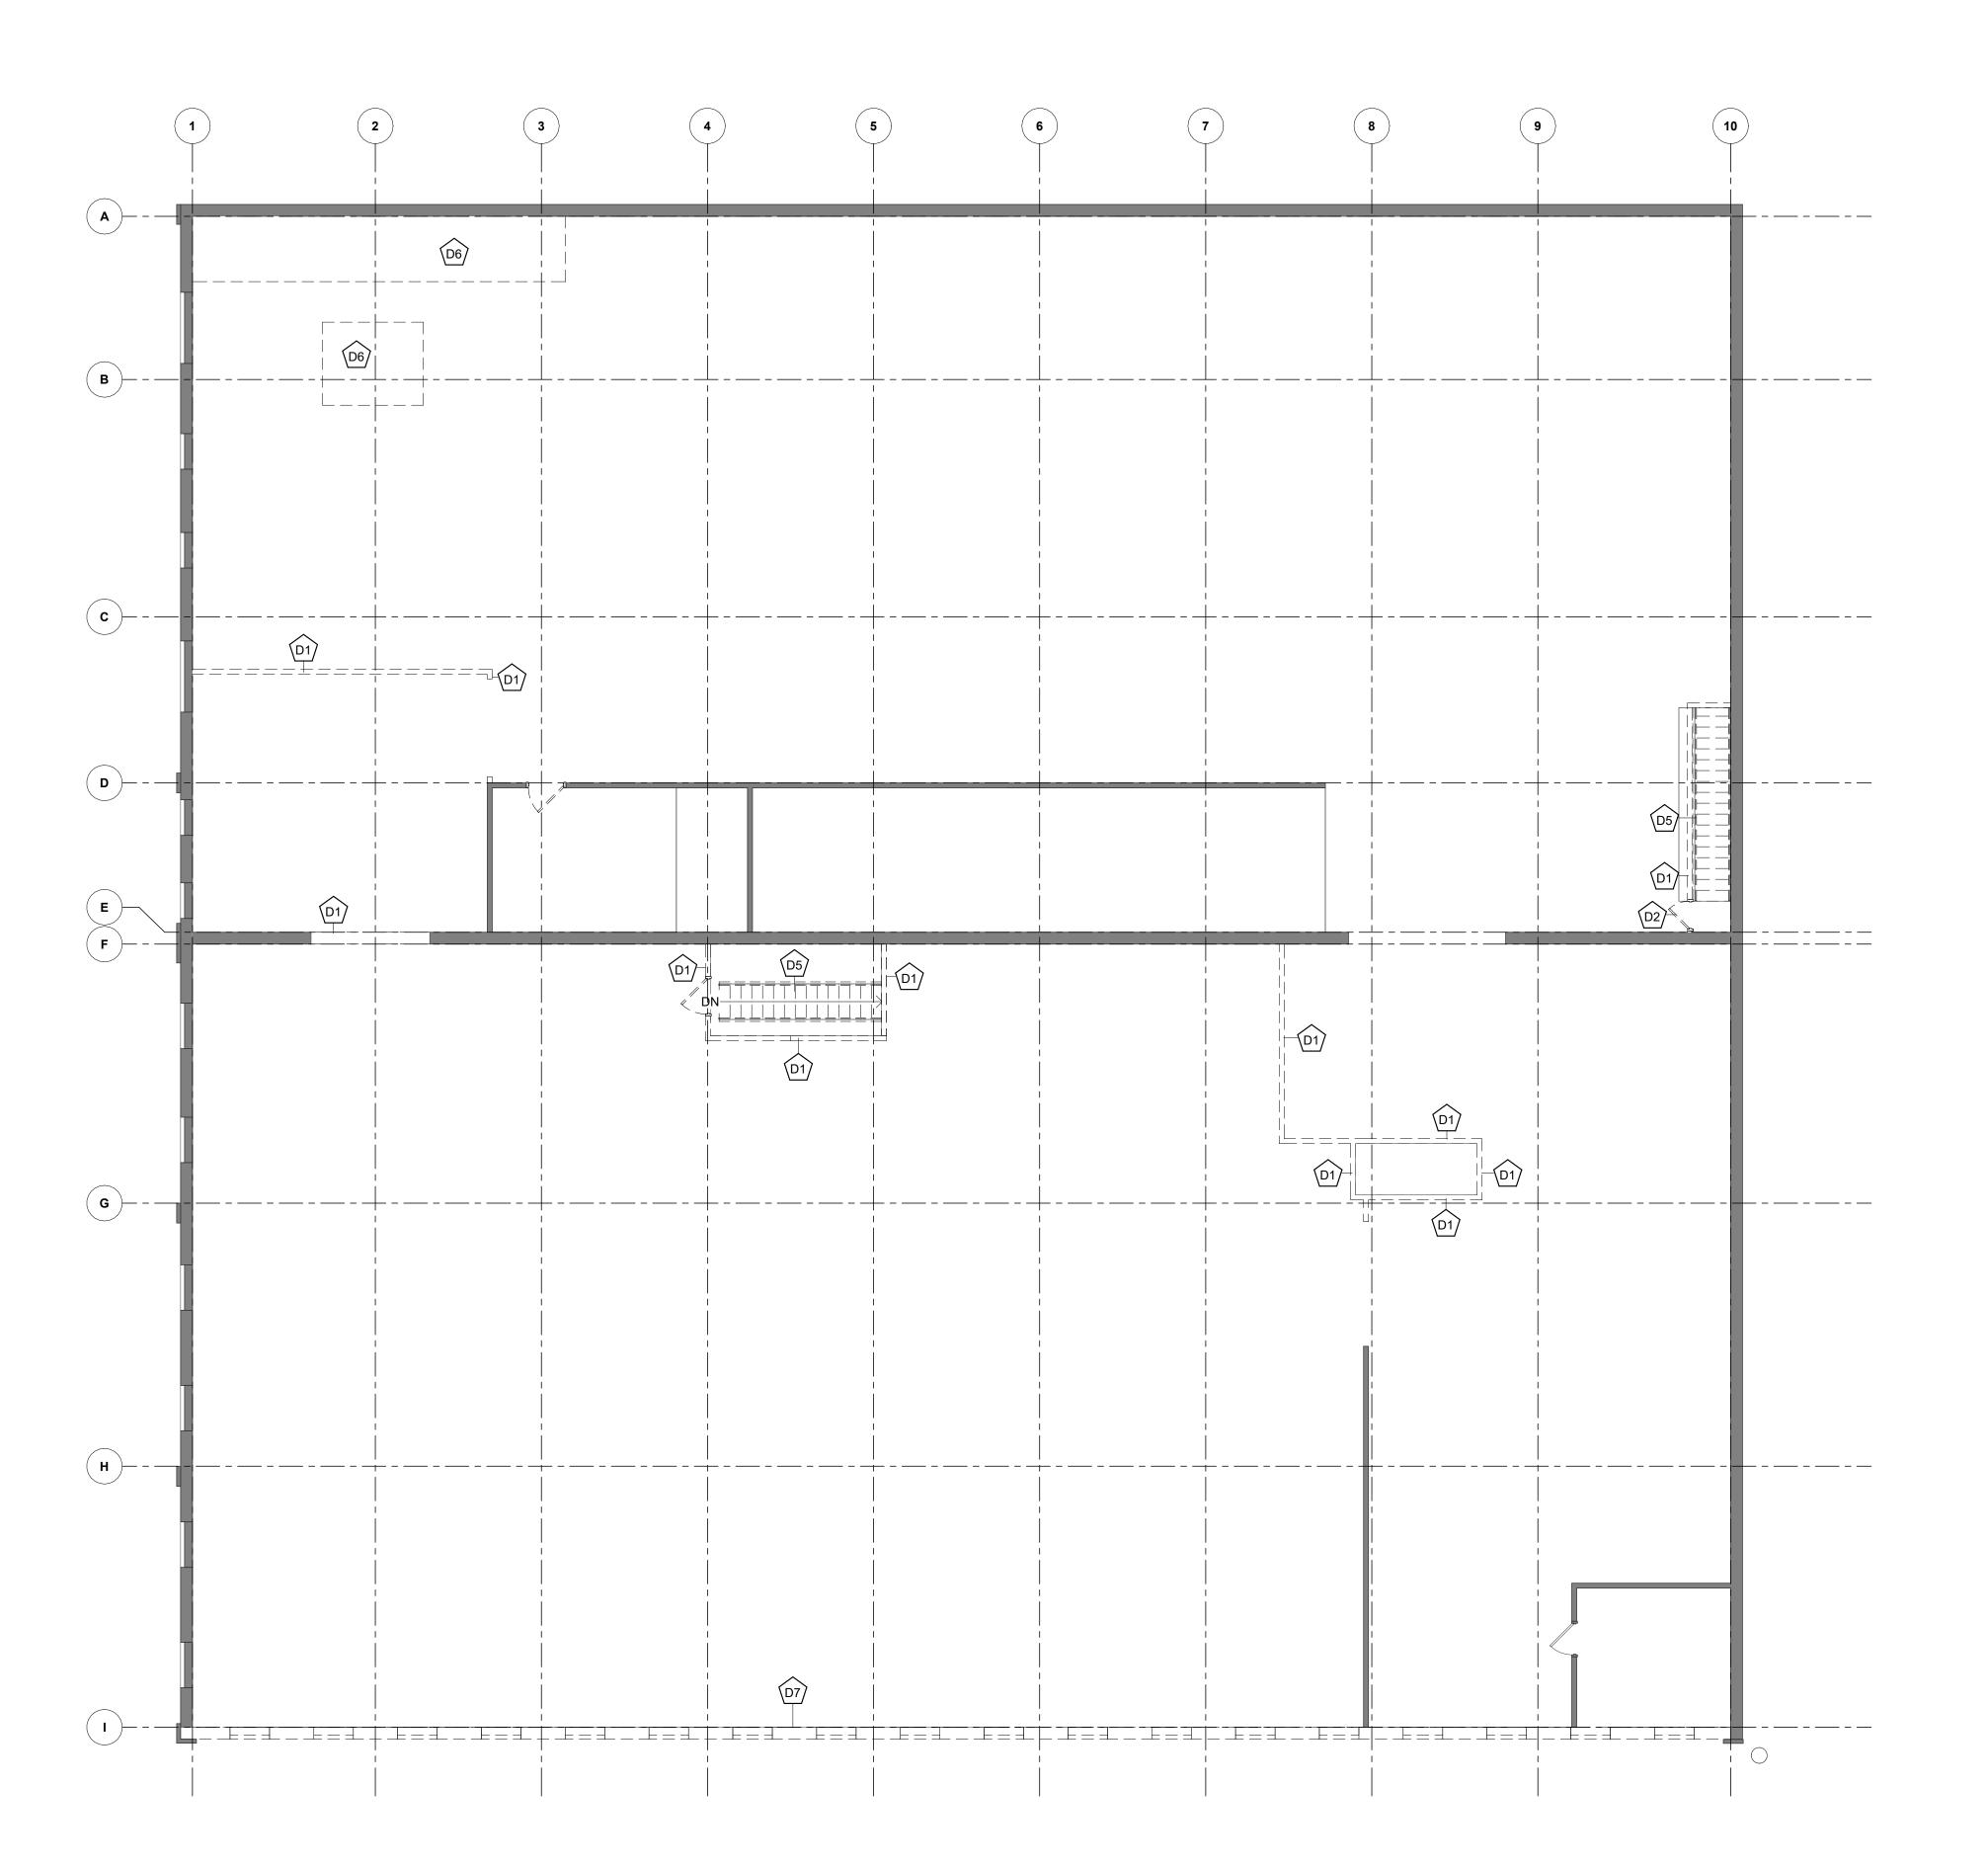
DEMOLITION PLAN - MAIN LEVEL

SHEET

AD1.1

DEMOLITION PLAN - MAIN LEVEL

AD1.1 SCALE: 1/8" = 1'-0"



KEYNOTES

D1 REMOVE EXISTING WALL TO EXTENTS INDICATED ON THE DRAWINGS.
D2 REMOVE DOOR AND FRAME.

D5 REMOVE EXISTING STAIRS AND ASSOCIATED COMPONENTS.

D6 REMOVE FLOORING AND ASSOCIATED COMPONENTS TO EXTENTS INDICATION ON THE DRAWINGS.

D7 REMOVE EXISTING EXTERIOR WALL AND ASSOCIATED COMPONENTS TO EXTENTS INDICATED ON THE DRAWINGS.

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SHEET TITLE


DEMOLITION PLAN - SECOND LEVEL

SHEET

AD1.2

DEMOLITION PLAN - SECOND LEVEL

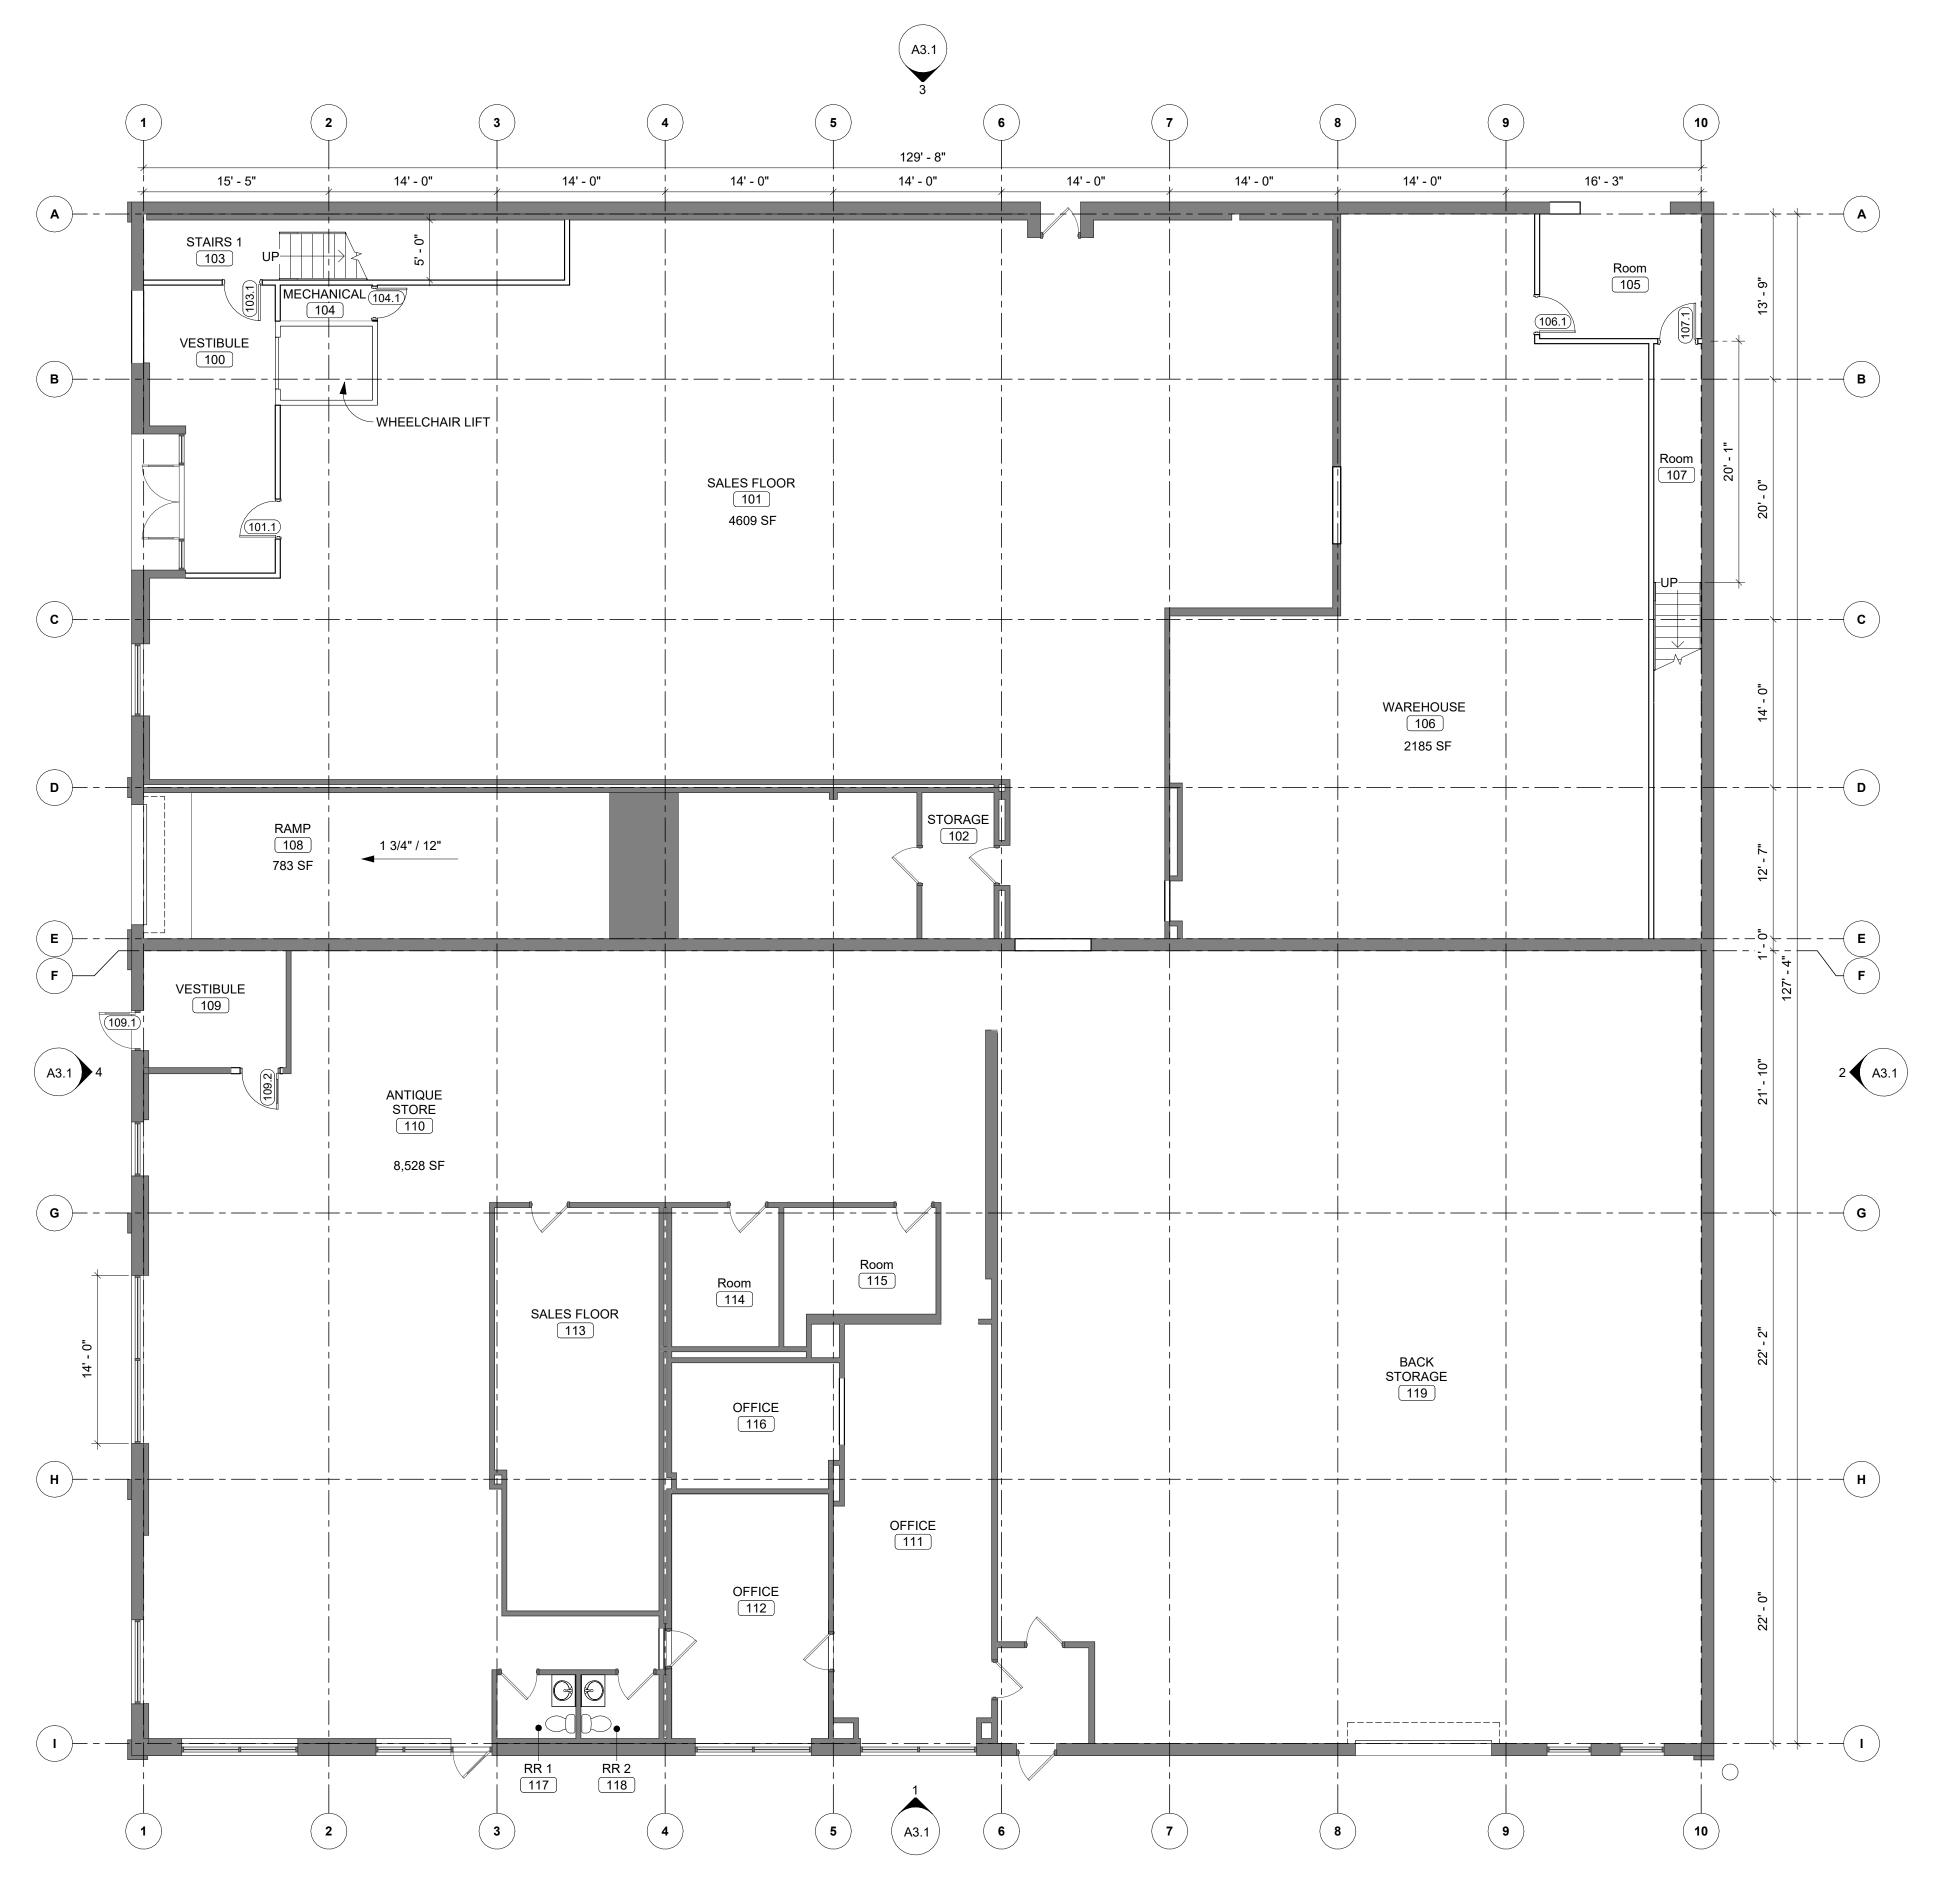AD1.2 SCALE: 1/8" = 1'-0"



NO.

1. XXX
2. XXX
3. XXX
4. XXX

KEYNOTES

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MIXED-USE TENANT REDEVELOPMENT

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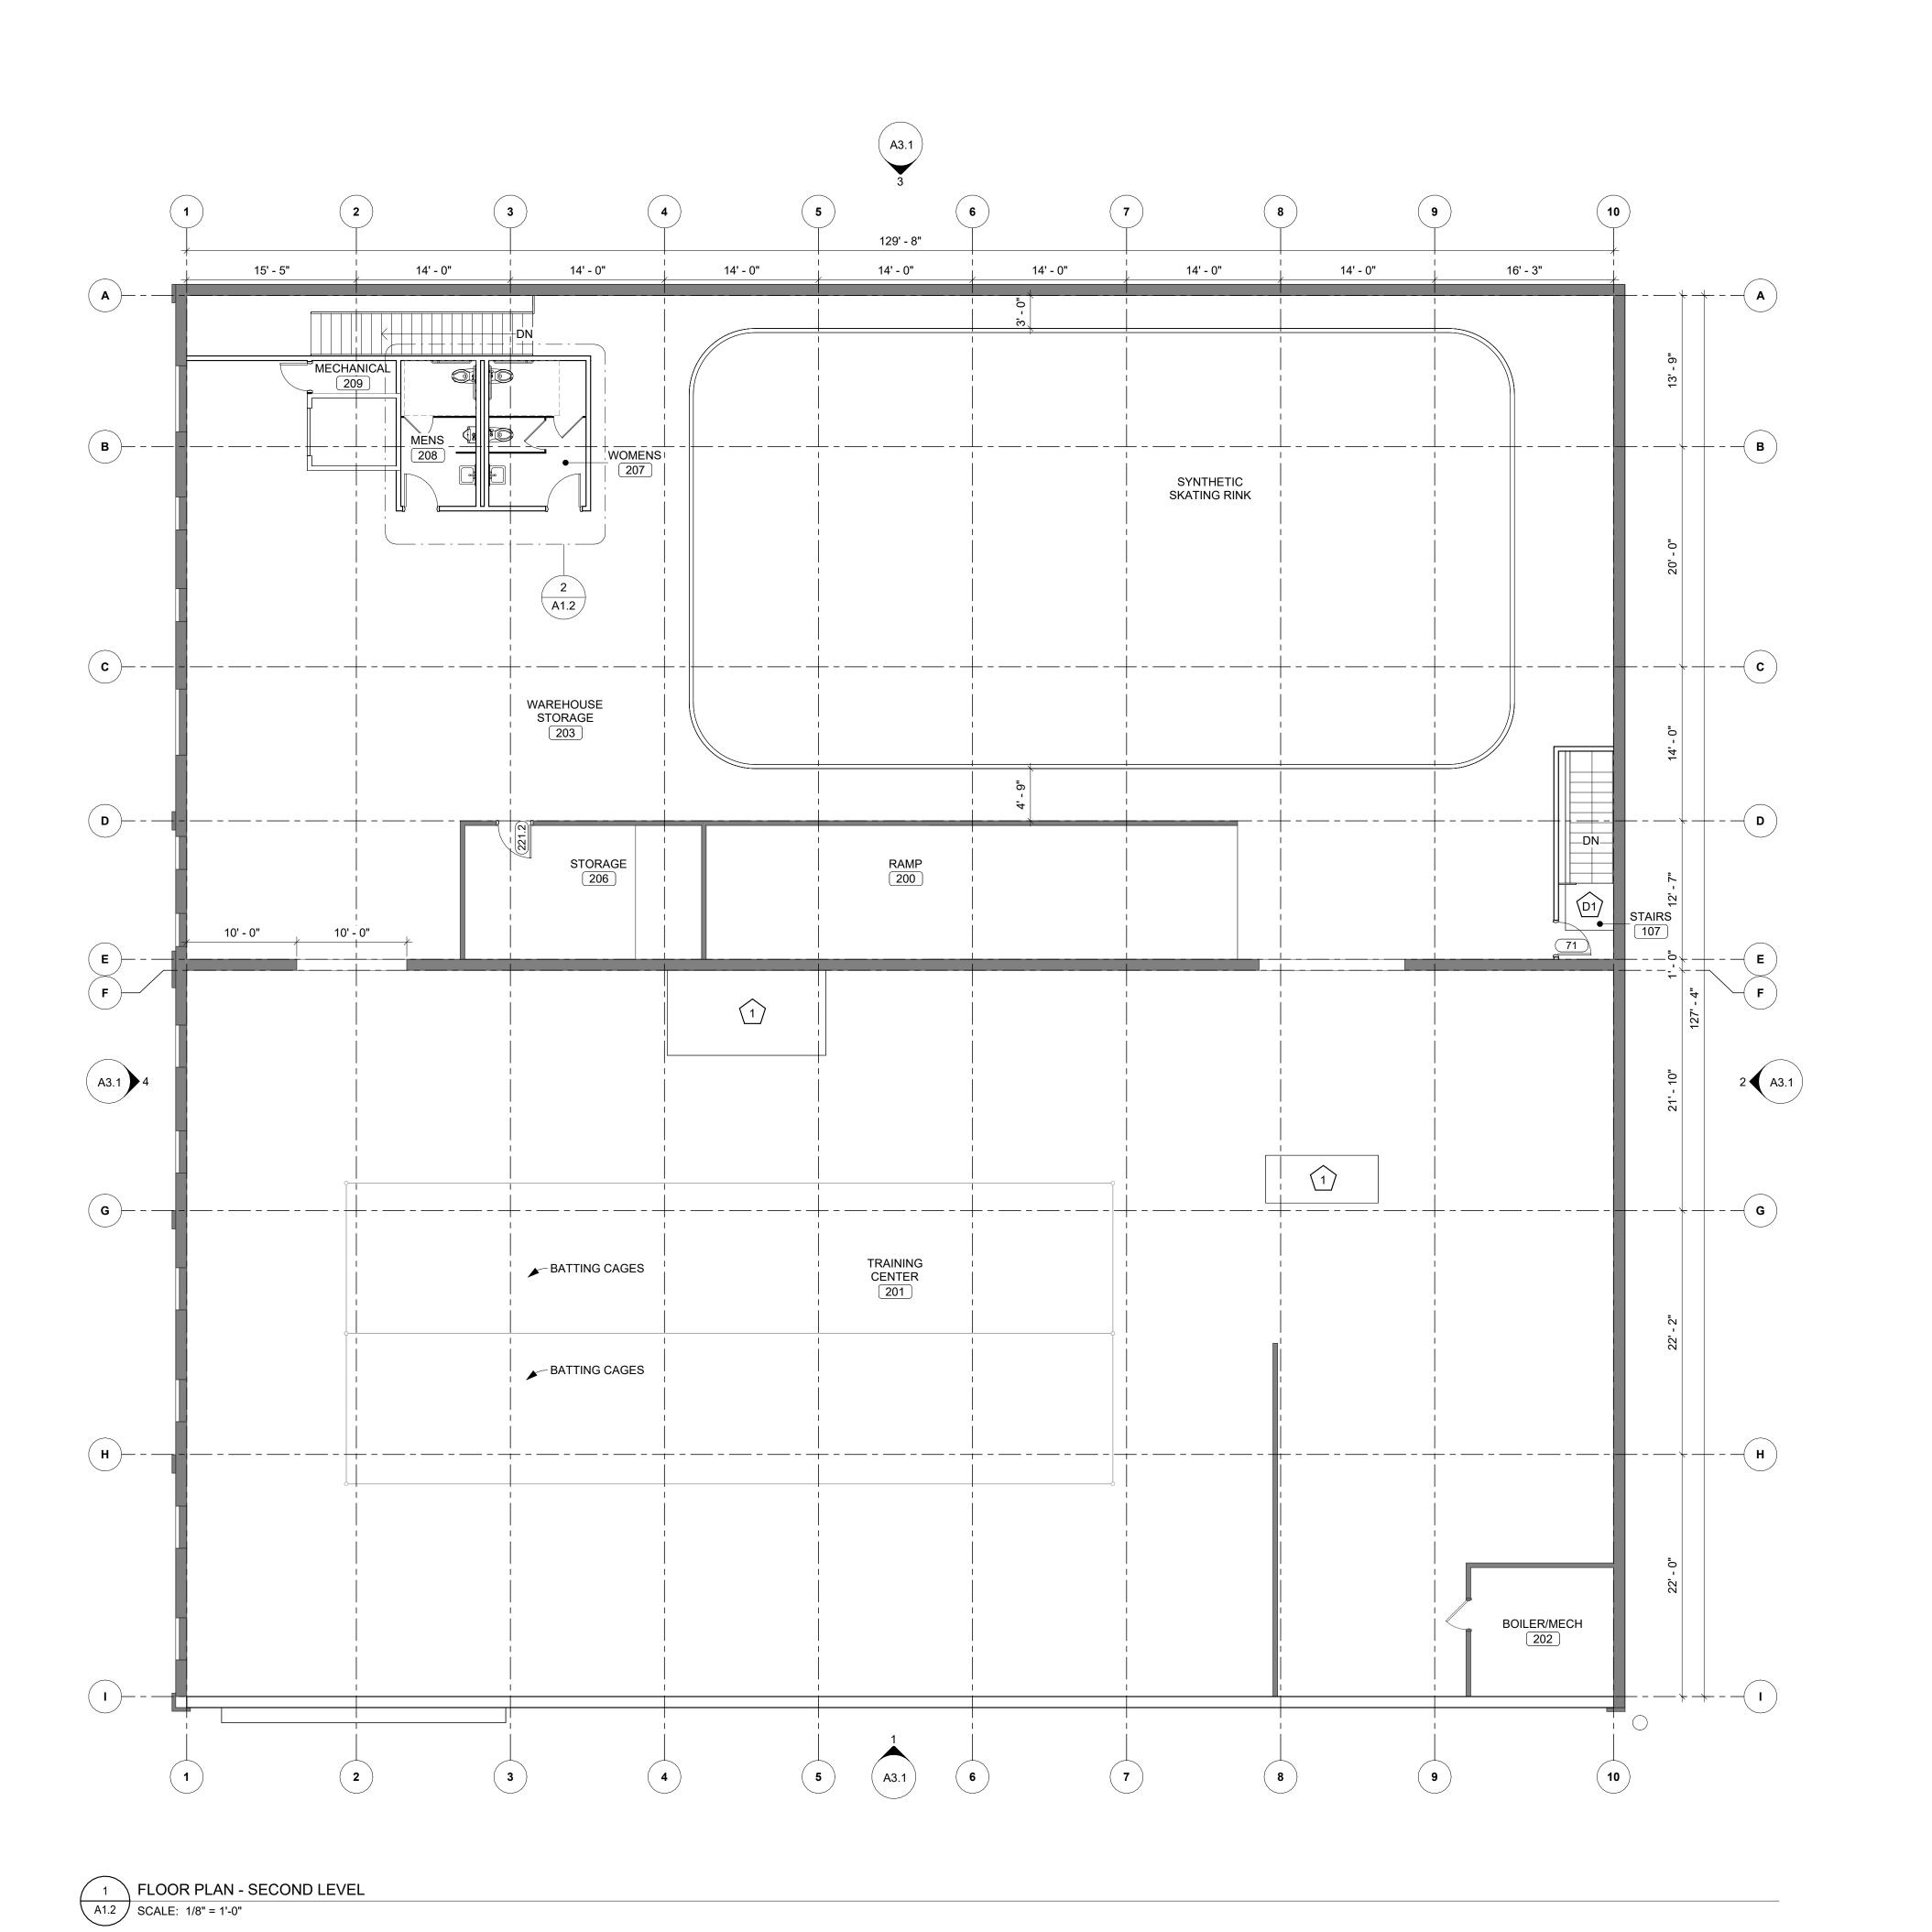
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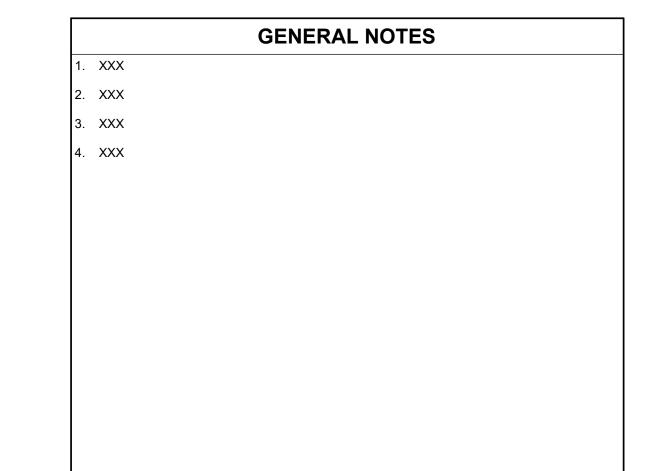
SHEET TITLE

FLOOR PLAN -MAIN LEVEL

SHEE

A1.1






KEYNOTES 1 INFILL FLOOR TO EXTENTS INDICATED AS THE DRAWINGS.

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> **MIXED-USE TENANT REDEVELOPMENT**

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ENLARGED SECOND LEVEL RESTROOM A1.2 SCALE: 1/4" = 1'-0"



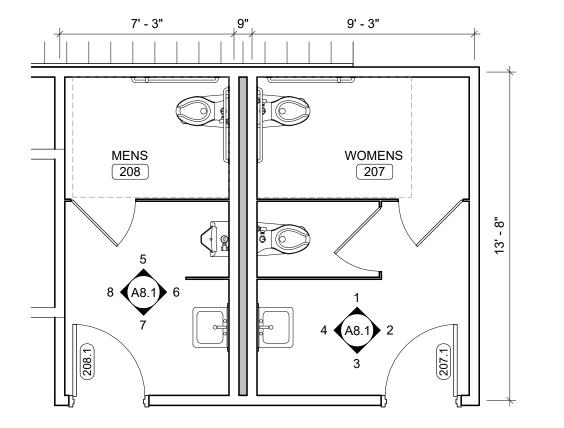FLOOR PLAN -SECOND LEVEL